




APD StormSlab® 220D TANKS
CLASS M SOILS - THREE STOREY
APD LTD

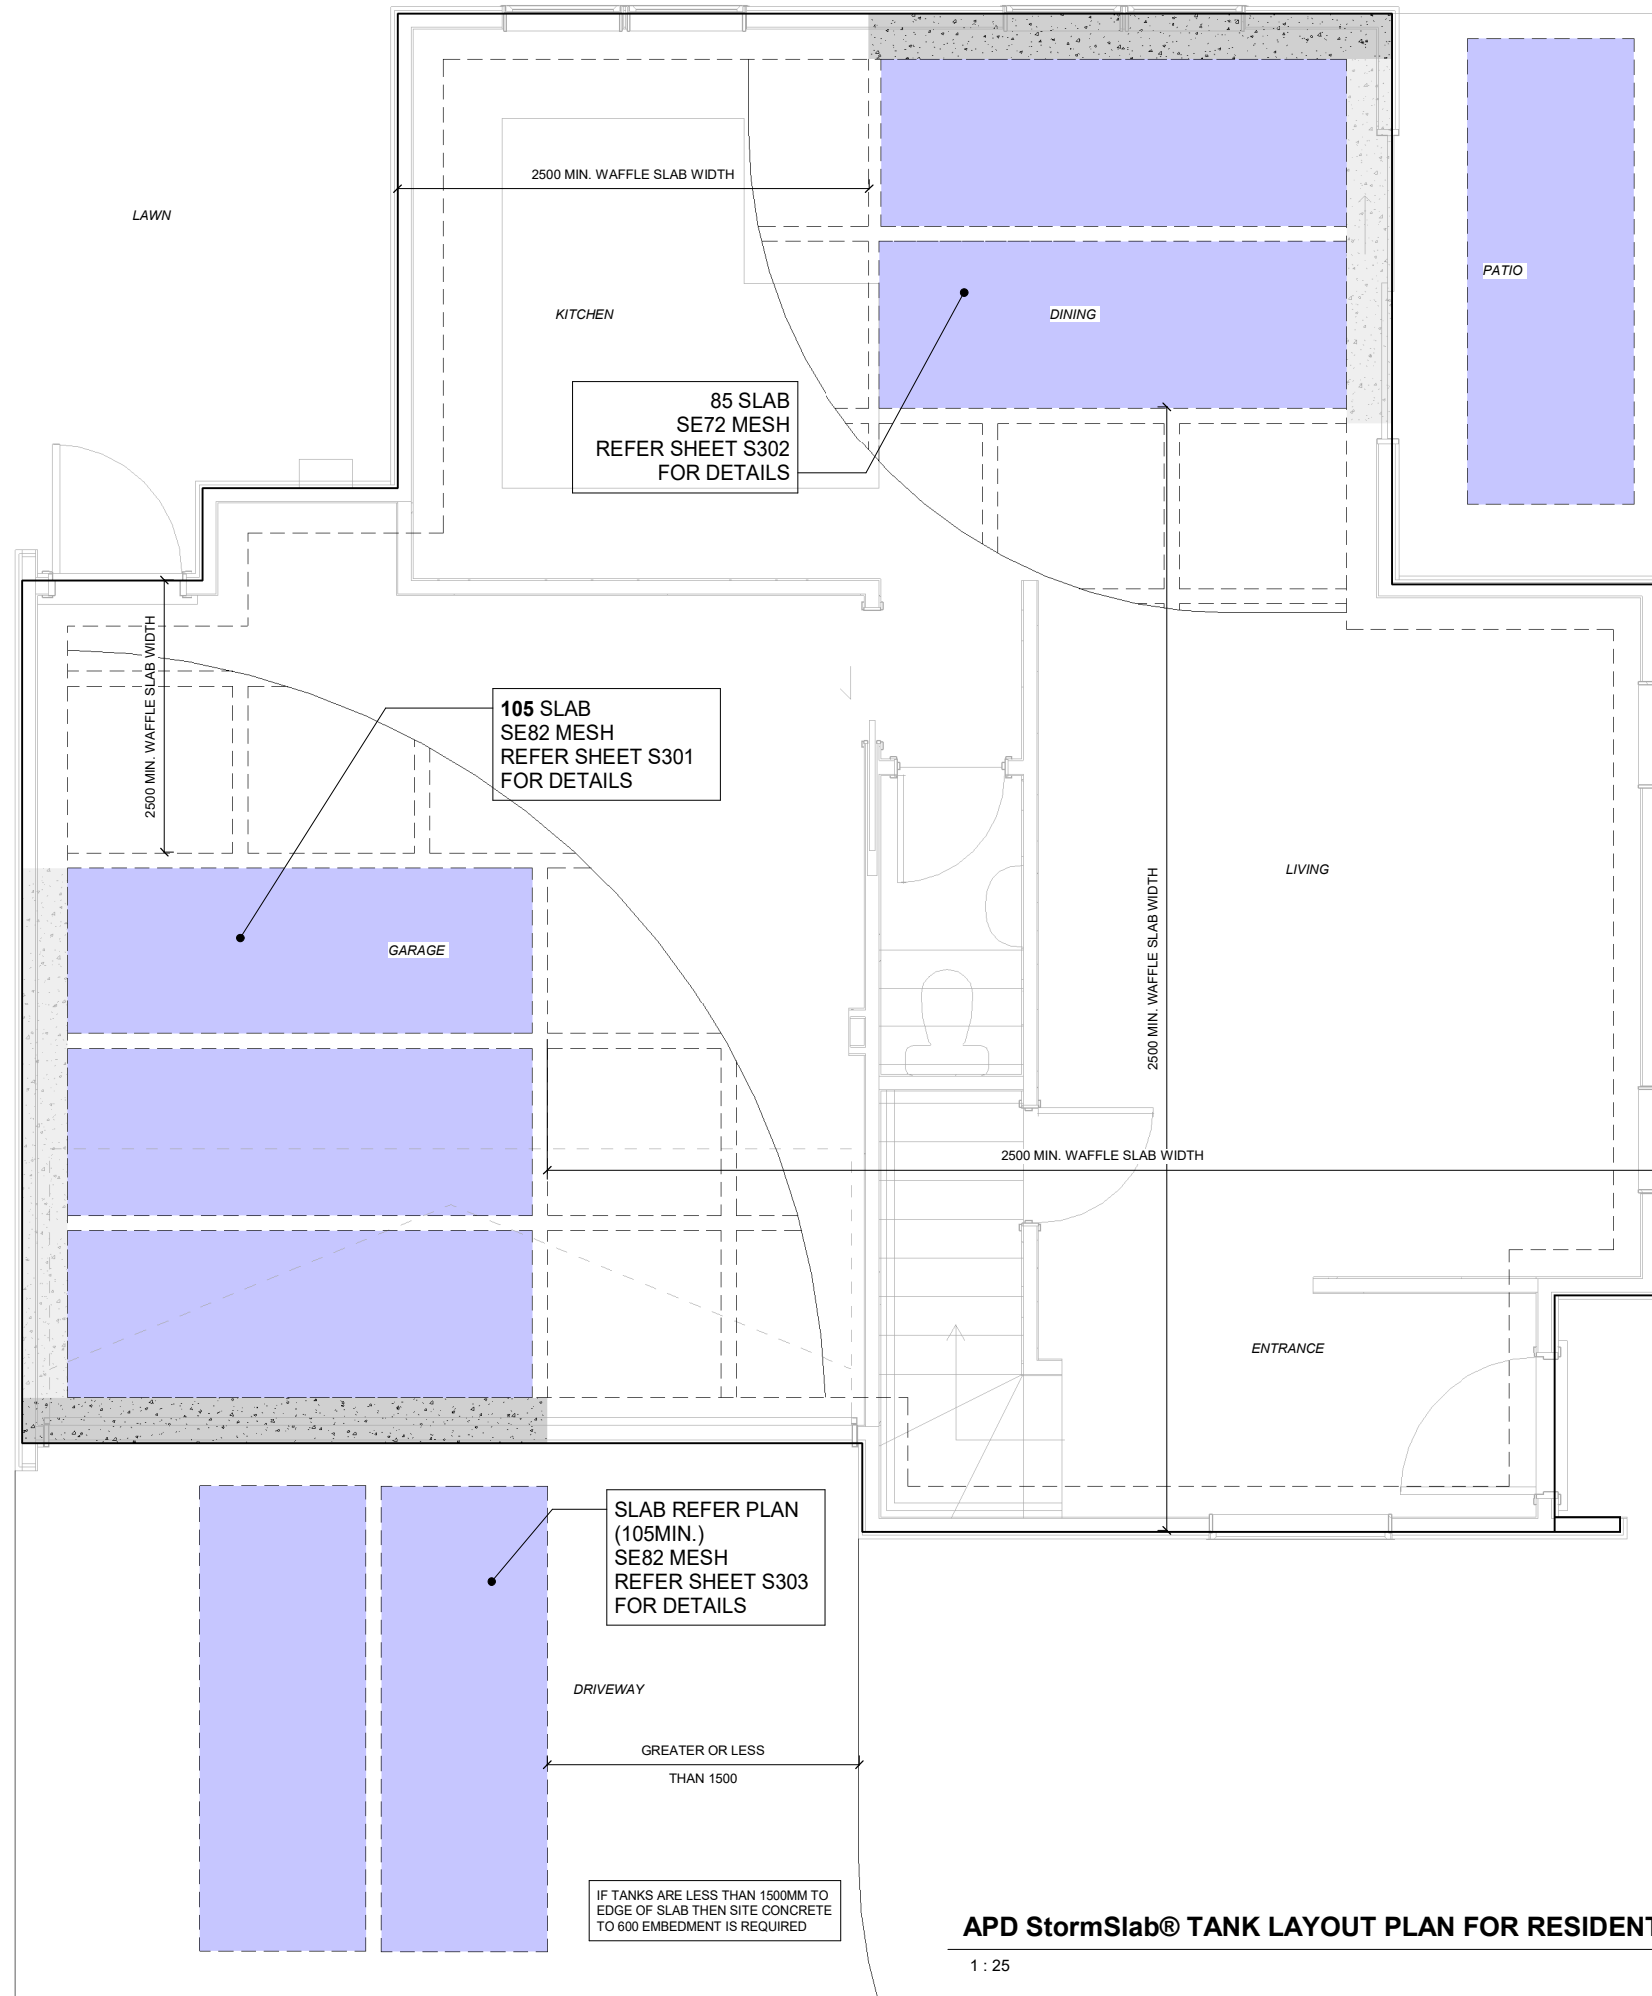

- NOTES:**
- REFER TO ARCHITECT'S DRAWINGS FOR BOUNDARY LINE SURVEY INFORMATION
 - REFER TO ARCHITECTURAL DRAWINGS FOR SETOUT
 - REFER TO ARCHITECTURAL DRAWINGS FOR ALL TIMBER FRAMING
 - REFER BELOW FOR CONCRETE STRENGTH
 - CONTRACTOR TO CONFIRM LOCATION OF EXISTING SERVICES WITH ENGINEER PRIOR TO COMMENCEMENT OF CONSTRUCTION
 - FOR REBATES & NIBS LOCATIONS REFER ARCH
 - REFER ARCH FOR SITE RETAINING WALLS

MAX UDL AND POINT LOADS AT PERIMETER FOOTING

WALL: G = 12.45KN/M (BRICK VENEER)
G = 3.24KN/M (WEATHER BOARD)

FLOOR: G = 3KN/M
Q = 7.5KN/M

ROOF: G = 1.35KN/M
Q = 0.75KN/M

GARAGE & DRIVEWAY:
G_{SDL} = 0.25KPA
Q = 2.5KPA
Q_{PL} = 12KN

CONCRETE STRENGTH:

20MPA
25MPA WITHIN SEASPRAY ZONE
30MPA WITHIN EXPOSURE CLASSIFICATION B2

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THE STRUCTURAL DRAWINGS MUST BE READ IN CONJUNCTION WITH THE ARCHITECTURAL AND ALL OTHER RELEVANT DRAWINGS ASSOCIATED WITH THE PROJECT.

A	26/04/24	FOR BUILDING CONSENT
REV	DATE	AMENDMENT

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STRUCTURAL | CIVIL

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Auckland 1011
Ph:09 520 0355 E: info@dhc.nz

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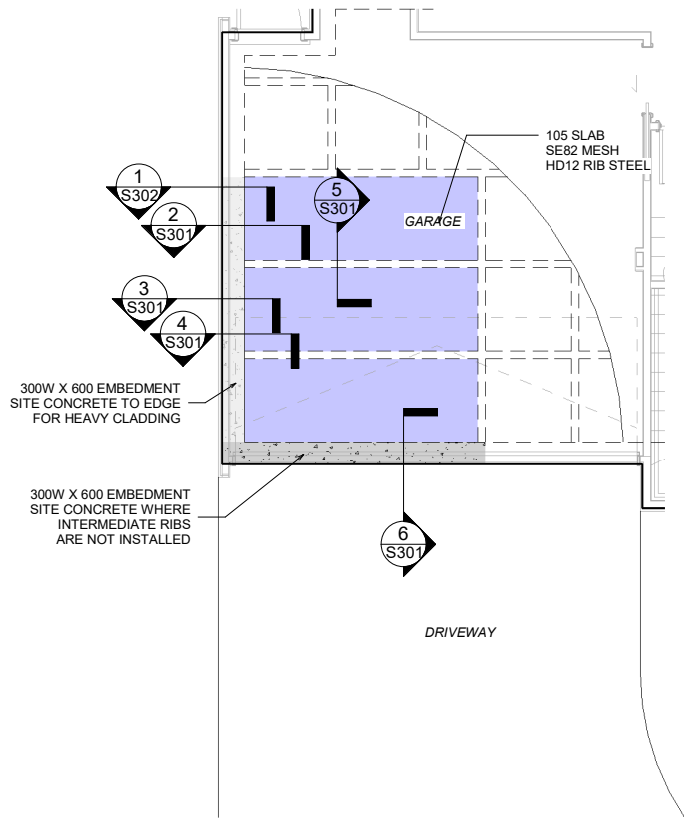
CLASS M SOILS - THREE STOREY - 220D TANKS

FOUNDATION PLAN WITH APD StormSlab®

DESIGNED	PS	DATE	26/04/24
DRAWN	PS	CHECKED	AH
A1 SCALE As indicated		A3 SCALE	
JOB No.	DWG No.	REVISION	
7527-M(3)	S101	A	


H:\JOB FOLDERS\7500-7599\7527-apd-in-slab-tanks\3.0 Working\2.0 DHC Drawings Files\3.0 Updated drawings
MCS 2024 - Tanks\220D\7527 - 2024.04.26 - 220D APD Tank - Walling with Details - Class M soil

30/05/2024 12:49:42 PM



RESIDENTIAL GARAGE SLAB WITH APD StormSlab®

1 : 50

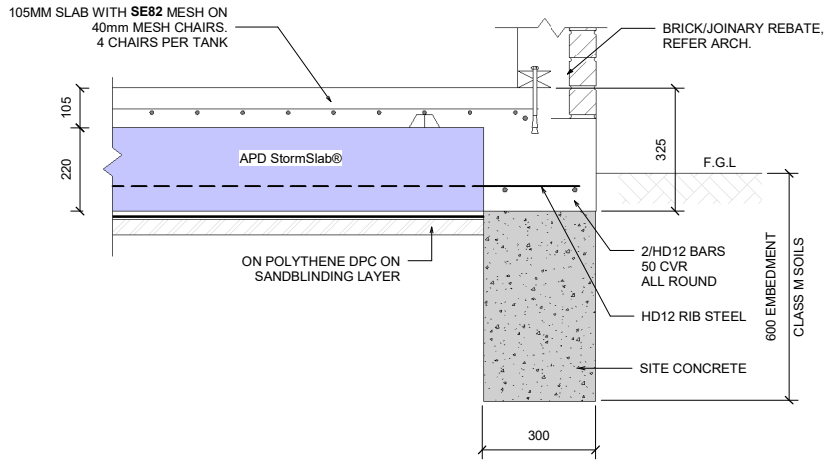


GARAGE SLAB - EDGE RIB WITH SITE CONCRETE.

1 : 10


CONSTRUCTION NOTES FOR WAFFLE SLAB

- CLEAR ALL TOPSOIL AND ORGANIC MATERIAL TO FORM CLEAN AND LEVEL BUILDING PLATFORM
- CONFIRM THAT THE GROUND CONDITIONS MEET NZS 3604:2011 GOOD GROUND WITH 300KPA ULTIMATE BEARING CAPACITY WITH SOIL EXPANSIVENESS NO GREATER THAN CLASS M, Ys = 40mm MAX.
- IMPORT HARDFILL IF REQUIRED TO RAISE GROUND LEVEL. COMPACTED IN 150 LOOSE LAYERS.
- COVER BUILDING PLATFORM WITH 25MM(MAX.) SAND BLINDING.
- COVER BLINDING WITH DPM, LAPPED AND TAPED, IN ACCORDANCE WITH NZS 3604.
- PLACE 1100 SQ POLYSTYRENE PANELS ON A 1200x1200 GRID TO PATTERN AS SHOWN.
- CUT ANY THICKENING FOR INTERNAL LOAD BEARING WALLS AND REINFORCE AS SHOWN.
- REFER TO ARCHITECT'S DRAWINGS FOR ALL SETOUT DIMENSIONS, REBATES AND SERVICES.
- POUR CONCRETE TOPPING SLAB, ALL THICKENINGS AND RIBS IN ONE OPERATION.
- SAW CUT AS SHOWN. 20MM DEEP IN CONCRETE SLAB IN ACCORDANCE WITH NZS 3604.
- CURE SLAB IN ACCORDANCE WITH NZS 3604 AND GOOD TRADES PRACTICE.

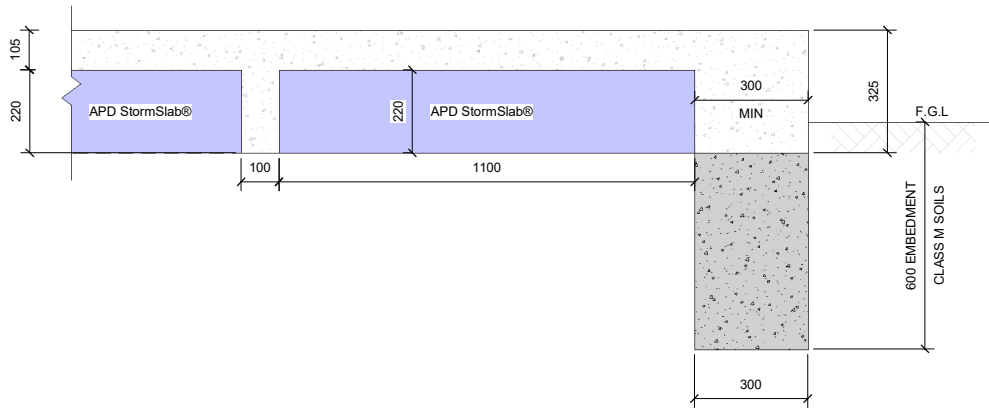


RESIDENTIAL GARAGE SLAB INSTALLATION WITH APD StormSlab®

1 : 10

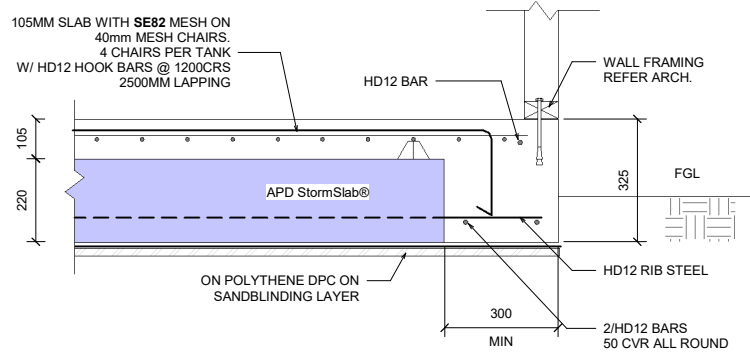


GARAGE SLAB - EDGE RIB

1 : 10

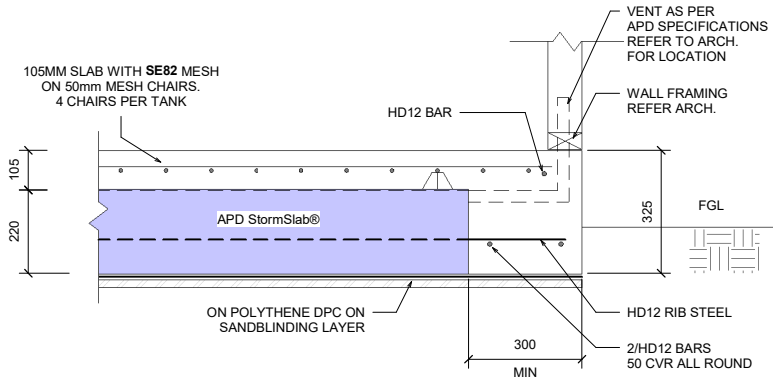


GARAGE SLAB - EDGE RIB WITH VENT

1 : 10

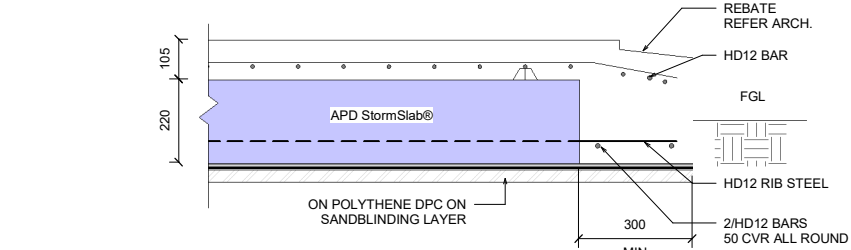


GARAGE SLAB - EDGE RIB WITH REBATE (WHERE APPLICABLE)

1 : 10

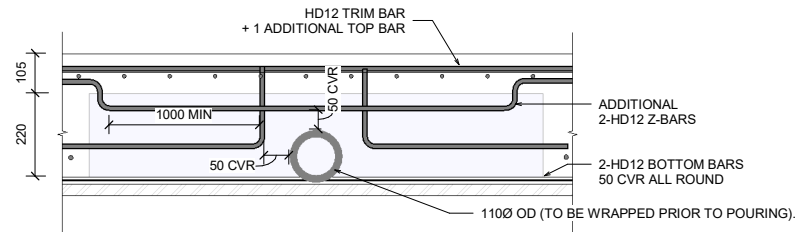


SECTION VIEW

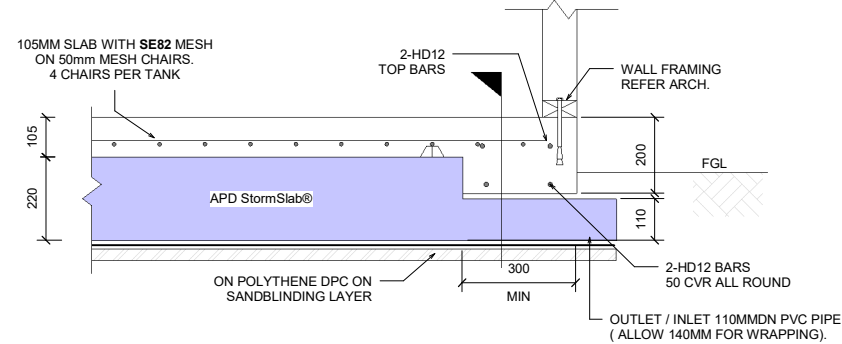


GARAGE SLAB - EDGE RIB WITH FLOW THROUGH

1 : 10

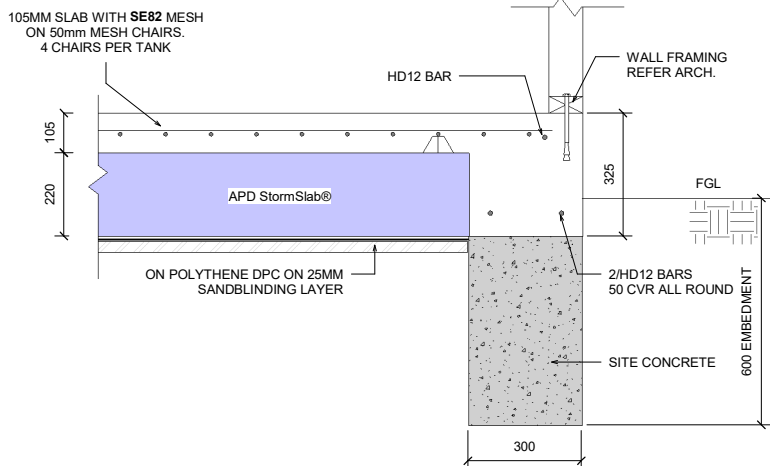

GARAGE SLAB - EDGE RIB WITH SITE CONCRETE

1 : 10

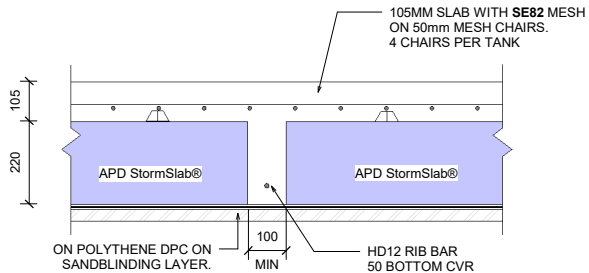

GARAGE SLAB - INTERNAL RIB

1 : 10

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CLASS M SOILS - THREE
STOREY - 220D TANKS

GARAGE SLAB DETAILS
WITH APD StormSlab®

DESIGNED	PS	DATE	26/04/24
DRAWN	PS	CHECKED	AH

A1 SCALE	A3 SCALE
As indicated	

JOB No.	DWG No.	REVISION
7527-M(3)	S301	A



RESIDENTIAL TYPICAL SLAB INSTALLATION WITH APD StormSlab®

85MM SLAB WITH **SE62** MESH ON 40mm MESH CHAIRS. 4 CHAIRS PER TANK

85

220

APD StormSlab®

APD StormSlab®

ON POLYTHENE DPC ON SANDBLINDING LAYER.

100

MIN

HD12 RIB BAR 50 BOTTOM CVR

This diagram illustrates the cross-section of a tank wall assembly. It shows two panels of APD StormSlab® installed side-by-side. Above the panels is an 85mm concrete slab with SE62 mesh on 40mm mesh chairs, with 4 chairs per tank. Below the panels is a polythene DPC on a sandblinding layer. A minimum 100mm gap is shown between the panels. HD12 rib bars with 50mm bottom cover are shown at the base of the panels.

TYPICAL SLAB - INTERNAL RIB

85MM SLAB WITH SE72 MESH ON 40mm MESH CHAIRS.
4 CHAIRS PER TANK
W/ HD12 HOOK BARS @ 1200CRS
2000MM LAPPING

HD12 BAR

WALL FRAMING REFER ARCH.

FGL

APD StormSlab®

ON POLYTHENE DPC ON SANDBLINDING LAYER

HD12 RIB STEEL

300 MIN

2/HD12 BARS 50 CVR ALL ROUND

85

220

305

② TYPICAL SLAB - EDGE RIB

85MM SLAB WITH SE72 MESH ON 40mm MESH CHAIRS. 4 CHAIRS PER TANK

BRICK/JOINERY REBATE. REFER ARCH.

85

220

APD StormSlab®

ON POLYTHENE DPC ON SANDBLINDING LAYER

305

F.G.L.

2/HD12 BARS
50 CVR
ALL ROUND

HD12 RIB STEEL

SITE CONCRETE

600 EMBEDMENT
CLASS IV SOILS

300

② TYPICAL SLAB - EDGE RIB WITH VENT

85MM SLAB WITH **SE62** MESH ON
50mm MESH CHAIRS.
4 CHAIRS PER TANK

HD12 BAR

VENT AS PER
APD SPECIFICATIONS
REFER TO ARCH.
FOR LOCATION

WALL FRAMING
REFER ARCH.

APD StormSlab®

ON POLYTHENE DPC ON
SANDBLINDING LAYER

HD12 RIB STEEL

2/HD12 BARS
50 CVR ALL ROUND

220

85

305

300

FGL

② TYPICAL SLAB - EDGE RIB WITH VENT

Diagram illustrating the cross-section of a concrete slab with a 1100mm diameter pipe. The slab thickness is 220mm. The reinforcement includes HD12 trim bars, 2-HD12 bottom bars, and 2-HD12 Z-bars. The distance between the reinforcement bars is 1000mm minimum. The concrete cover (CVR) is 50mm. The total height of the slab is 105mm. The pipe is 1100mm OD (to be wrapped prior to pouring).

4 TYPICAL SLAB - EDGE RIB WITH FLOW THROUGH

85MM SLAB WITH **SE62** MESH ON 40mm MESH CHAIRS. 4 CHAIRS PER TANK

2-HD12 TOP BARS

WALL FRAMING REFER ARCH.

85

220

APD StormSlab®

180

FGL

110

ON POLYTHENE DPC ON SANDBLINDING LAYER

300 MIN

2-HD12 BARS 50 CVR ALL ROUND

OUTLET / INLET 100MMDN PVC PIPE (ALLOW 140MM FOR WRAPPING)

4 TYPICAL SLAB - EDGE RIB WITH FLOW THROUGH

85MM SLAB WITH **SE62** MESH ON
40mm MESH CHAIRS.
4 CHAIRS PER TANK

85

220

APD StormSlab®

220

ON POLYTHENE DPC ON
SANDBLINDING LAYER

300

MIN

2/HD12 BARS
50 CVR ALL
ROUND

TYPICAL SLAB - INTERNAL THICKENING

85MM SLAB WITH SE62 MESH ON
40mm MESH CHAIRS.
4 CHAIRS PER TANK

HD12 BAR

WALL FRAMING REFER ARCH.

85

220

APD StormSlab®

ON POLYTHENE DPC ON
SANDBLINDING LAYER

305

FGL

2/HD12 BARS
50 CVR ALL ROUND

SITE CONCRETE

600 EMBEDMENT

300

6 TYPICAL SLAB - EDGE RIB WITH SITE CONCRETE

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CLASS M SOILS - THREE STOREY - 220D TANKS

TYPICAL SLAB DETAILS WITH APD StormSlab®

DESIGNED	PS	DATE	26/04/24
DRAWN	PS	CHECKED	AH
A1 SCALE As indicated		A3 SCALE	
JOB No.	DWG No.		REVISION
7527-M(3)	S302		A

3/05/2024 12:49:43 PM H:\JOB FOLDERS\7500-7599\7527-apd-inslab-tanks\3.0 Working\2.0 DHC Drawings Files\3.0 Updated drawings MAP 2024 - Trench\2200\7527 - 2024 04 26 - 2200 ANP Tank - Waffle slab Details - Class M(3) v1

